

California High-Speed Rail Authority



RFP No.: HSR 13-57

**Request for Proposals for Design-Build
Services for Construction Package 2-3**


**Book IV, Part F.2
Plans Preparation Manual Changes**

ROADWAY CIVIL (**See Note 2)	
ROADWAY CIVIL - GENERAL NOTES	NO SCALE
ROADWAY CIVIL - INDEX MAP	VARIABLES
ROADWAY CIVIL - EXISTING TOPOGRAPHY AND DEMOLITION PLANS	1"=50'
ROADWAY CIVIL - TYPICAL SECTIONS	NO SCALE
ROADWAY CIVIL - GRADE SEPARATION - "STREET NAME"	-
<i>PLAN</i>	1" = 50'
<i>PROFILE</i>	H: 1" = 50' ; V: 1"=10'
<i>TYPICAL SECTION</i>	1" = 10'
<i>ALIGNMENT CURVE DATA</i>	NO SCALE
<i>RETAINING WALL (ID, LENGTH, AVERAGE HEIGHT)</i>	NO SCALE
ROADWAY CIVIL - GRADING AND DRAINAGE PLAN	1" = 50'
ROADWAY CIVIL - DRAINAGE SECTION AND DETAILS	VARIABLES
ROADWAY CIVIL - TEMPORARY WATER POLLUTION PREVENTION PLANS	1"=50'
ROADWAY CIVIL - TEMPORARY WATER POLLUTION PREVENTION DETAILS	VARIABLES
ROADWAY CIVIL - EROSION CONTROL PLANS	1"=50'
ROADWAY CIVIL - EROSION CONTROL DETAILS	VARIABLES
ROADWAY CIVIL - WATER POLLUTION PREVENTION PLANS	1"=50'
ROADWAY CIVIL - WATER POLLUTION PREVENTION DETAILS	VARIABLES
ROADWAY CIVIL - STAGE CONSTRUCTION PLAN	1"=100' OR 1"=200'
ROADWAY CIVIL - STAGE CONSTRUCTION DETAILS	VARIABLES
ROADWAY CIVIL - TRAFFIC HANDLING PLAN	1"=100' OR 1"=200'
ROADWAY CIVIL - TRAFFIC HANDLING DETAILS	VARIABLES
ROADWAY CIVIL - SIGN PLANS	1"=50'
ROADWAY CIVIL - SIGN DETAILS	VARIABLES
ROADWAY STRUCTURES (**See Note 2)	
ROADWAY STRUCTURES - GENERAL NOTES	NO SCALE
ROADWAY STRUCTURES - GENERAL PLAN	-
<i>PROFILE GRADE</i>	NO SCALE
<i>ELEVATION</i>	MATCH PLAN
<i>PLAN</i>	1" = 20' , 1" = 30 or 1" = 40' (DETERMINED BY SIZE OF STRUCTURE)
<i>TYPICAL SECTION</i>	1" = 10'
<i>RETAINING WALL (ID, LENGTH, AVERAGE HEIGHT)</i>	NO SCALE
ROADWAY STRUCTURES - FOUNDATION PLAN	DETERMINED BY SIZE OF STRUCTURE
ROADWAY STRUCTURES - FOUNDATION DETAILS	VARIABLES
ROADWAY STRUCTURES - ABUTMENT PLAN AND ELEVATION	-
<i>ELEVATION</i>	MATCH PLAN
<i>PLAN</i>	DETERMINED BY SIZE OF STRUCTURE

RFP No.: 13-57 – Addendum No. 5 - 10/09/2014




6/3/2014 3:08:39 PM CAHSR-PPM-10HSR_half_black.plt c:\projects\p\p\project\wise\p\project\wise\int\m\incio\dms51960\09-Track-Structures-Plan-Sample.dgn

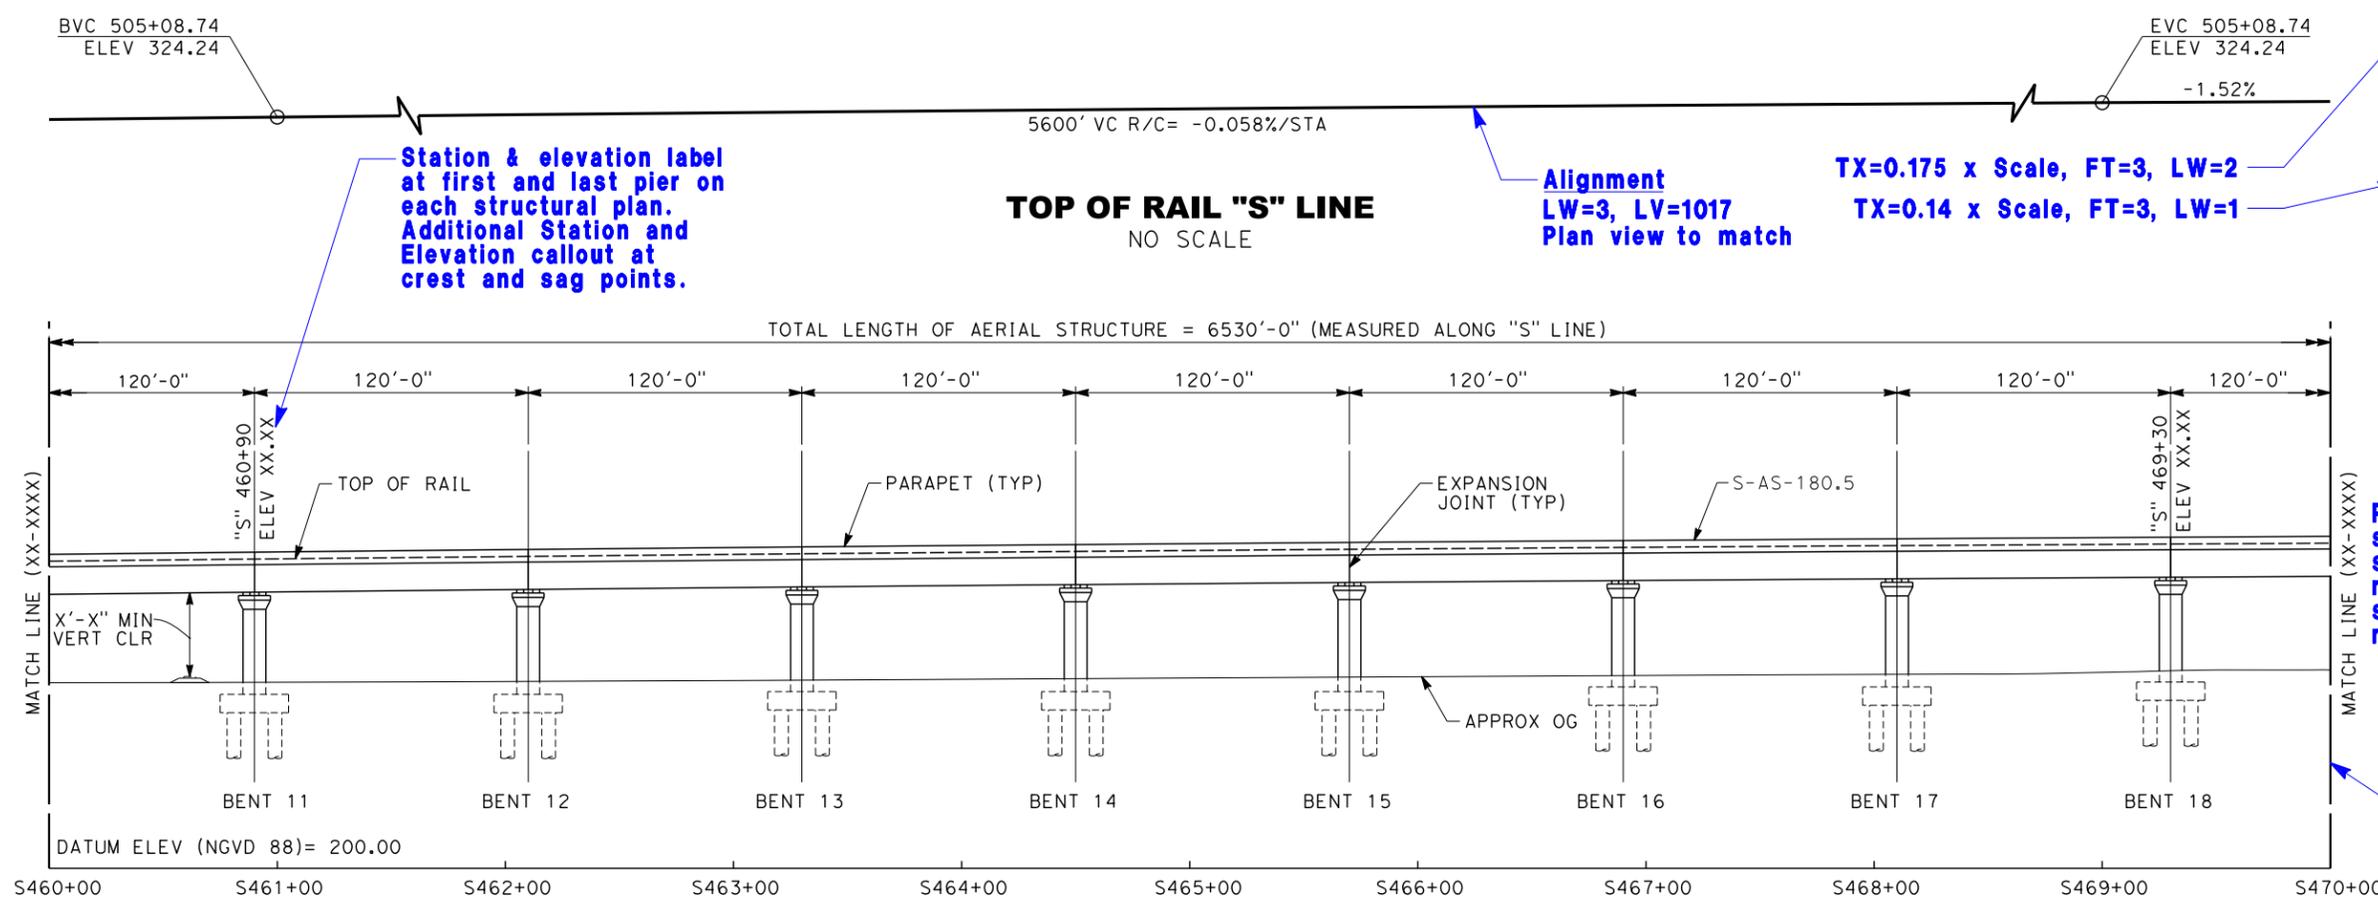

- NOTES:**
- FOR DETAILS NOT NOTED, SEE DRAWING NO. SV2201
 - GRADE ELEVATIONS SHOWN ARE EQUAL TO TOP OF RAIL.
 - ALL PIERS ARE NORMAL TO THE STATION LINE UNLESS OTHERWISE SHOWN.
 - REFER TO TRACK ALIGNMENT DATA TABLE FOR CURVE AND TANGENT INFORMATION.

Place Notes #2-4 on the first sheet of structural plan. On subsequent sheet, make a note referencing back to the first structural plan sheet. Not required for each sheet.

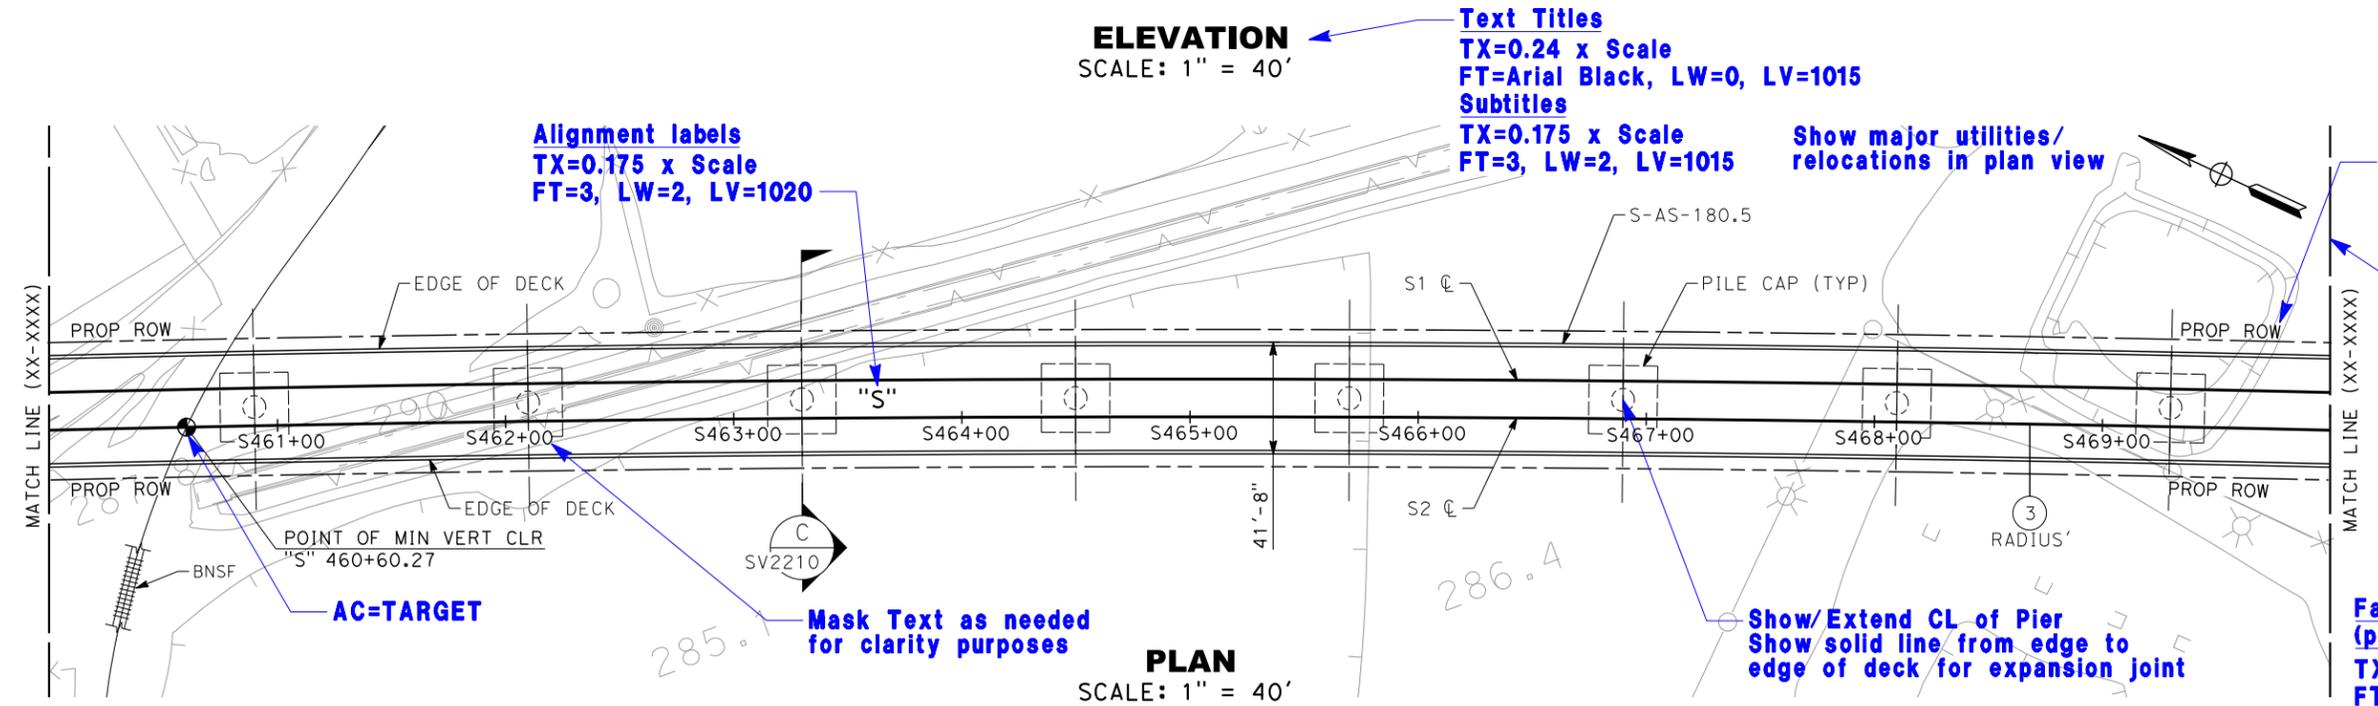

TRACK STRUCTURES PLAN SAMPLE

FID: S-AS-180.51

Sample Plan					
For purposes of procurement, additional coordination is required between RC's and PMT					
REV	DATE	BY	CHK	APP	DESCRIPTION

DESIGNED BY J. DOE
DRAWN BY J. DOE
CHECKED BY J. DOE
IN CHARGE J. DOE
DATE
##/##/####

PROPOSED PRELIMINARY DESIGN

NOT FOR CONSTRUCTION



CALIFORNIA HIGH-SPEED TRAIN PROJECT

SEGMENT/PACKAGE

TRACK STRUCTURES
STRUCTURAL PLAN

CONTRACT NO.
DRAWING NO. TT-D3001
SCALE AS SHOWN
SHEET NO.

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